



PROPOSED ANTENNA DETAILS												
I.D. No.	ITEM	TYPE / SIZE	BEARING	MEAN HEIGHT	MECH TILT	FUNC.	FEEDER LENGTH	FEEDER TYPE	LNA/ MHA	No. OF FEEDERS	RET/ VET	
T.B.C	A1	UHF 4L CARDIOID IN CYLINDER	350° E.T.N.	16.9m	-	Tx	-	LCF-7/8	-	1	NO	
T.B.C	A2	2 No. UHF BAYED LOGS	285° E.T.N.	14.3m	-	Rx	-	LCF12-50	-	1	NO	

©2010 Arqiva  
 All rights reserved. No part of this publication may be reproduced, stored in a retrieval system or transmitted in any form or by any means (Electronic, Mechanical, Photocopying, Recording or otherwise), without the prior written consent of the Company.


NOTES

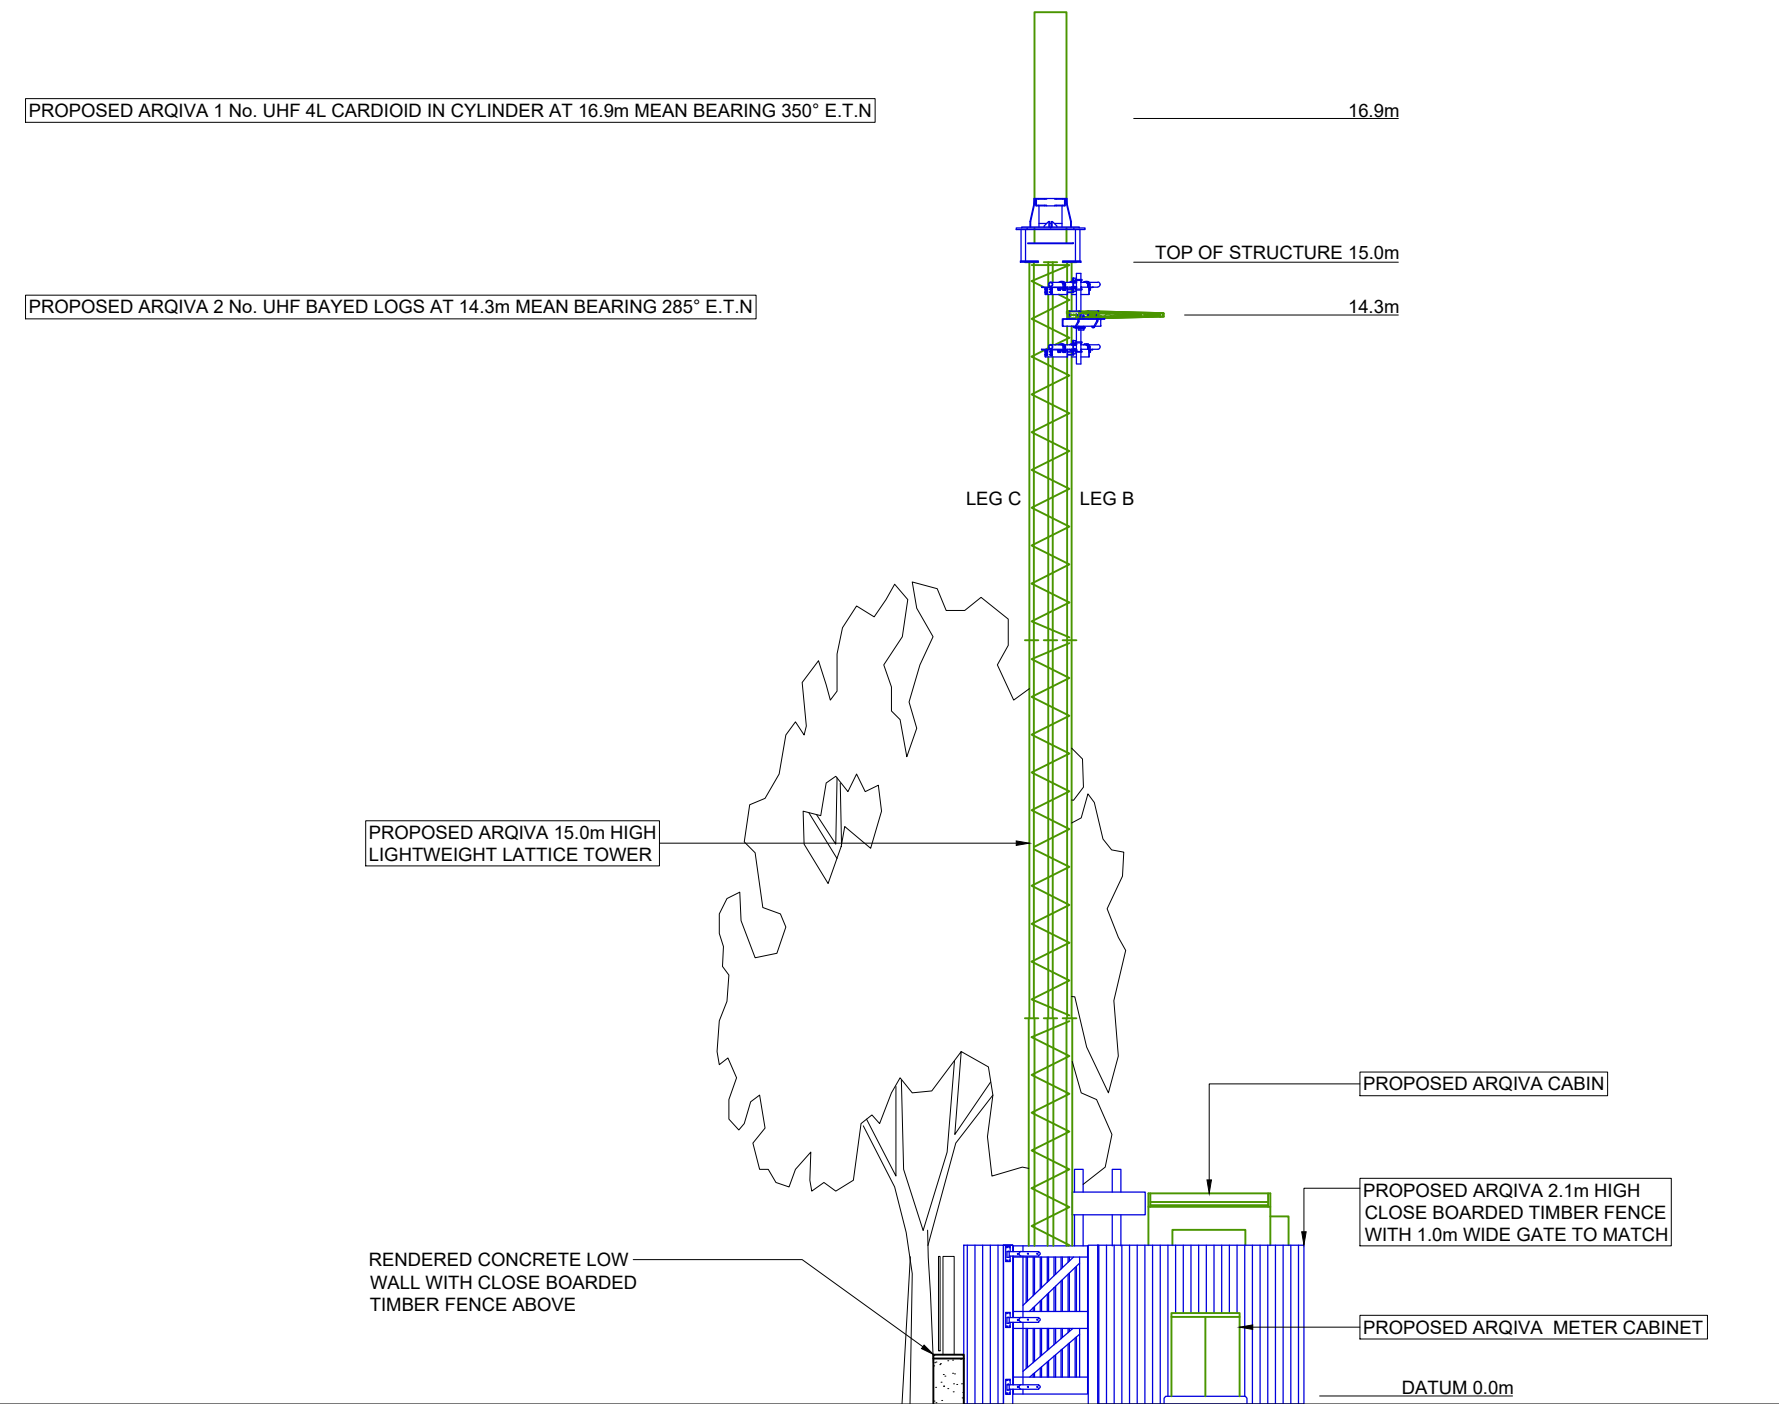


PROPOSED ARQIVA  
 1 No. UHF 4L CARDIOID  
 IN CYLINDER  
 16.9m MEAN  
 350° E.T.N  
 ID No. T.B.C

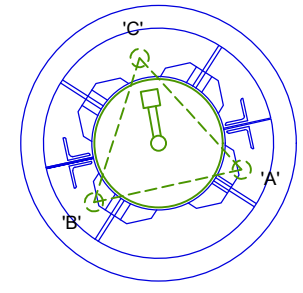

PROPOSED ARQIVA  
 2 No. UHF BAYED LOGS  
 14.3m MEAN  
 285° E.T.N  
 ID No. T.B.C

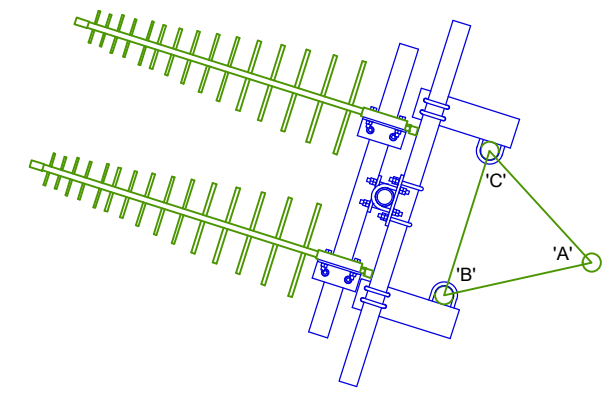

NORTH WEST ELEVATION

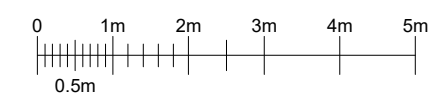

FEINT DETAILS INDICATE LOCATIONS RESERVED FOR OTHER PROPOSALS WHICH MAY BE THE SUBJECT OF SEPARATE APPLICATIONS

PROJ No				
PROJ No				
PROJ No				
PROJ No	N/A	25/08/20	PS	SH
2	REVISED PLANNING ISSUE			
PROJ No	N/A			
1	FIRST ISSUE	07/05/20	KML	IM
ISS	REVISION	DATE	DRN	APP

**arqiva**

Crawley Court, Winchester, Hampshire, SO21 2QA  
 Tel. 01962 823434, Fax. 01962 822378

SITE No **307251**  
 ST PETER PORT MOUNT DURAND  
 CAR PARK BETWEEN 32 & 36 MOUNT DURAND  
 MOUNT DURAND  
 ST PETER PORT  
 GUERNSEY  
 GY1 1DZ

NGR

OS GRID

TITLE  
 ELEVATION - OPTION 1  
 PROPOSED LATTICE TOWER  
 ARQIVA

SCALE 1:100

DRAWN	KML	01/05/20
APPROVED	SH	25/08/20

DRG No. 307251-01-150-MD002 Sheet 1 of 1 Rev 2